#### PURPOSE

TO LIMIT THE EXTENT OF DISTURBED SOILS BY CONFINING EARTH DISTURBING ACTIVITIES TO THE APPROPRIATE AREAS. TO DIRECTLY PROTECT WATERS OF THE STATE AND VEGETATED BUFFERS SURROUNDING THEM FROM NECESSARY DISTURBANCE.

CONDITION WHERE PRACTICE APPLIES

WHERE THE BORDER OF AUTHORIZED DISTURBANCE BORDERS AREAS OF EXISTING VEGETATION OR WITHIN 100 FEET OF WATERS OF THE STATE.

#### CRITERIA


LIMITS OF DISTURBANCE (LOD'S) SHOULD BE THE FIRST CONSTRUCTION ITEM IMPLEMENTED ON A CONSTRUCTION SITE. ALL DISTURBANCE AREAS BORDERING AREAS OF EXISTING VEGETATION SHOULD BE DEMARCATED WITH A BARRIER APPROPRIATE TO THE LOCATION.


FLAGGING RIBBON/PAINT: FOR USE WHERE PROPOSED DISTURBANCE BORDERS ESTABLISHED WOODED AREAS WHERE INADVERTENT DISTURBANCE BY MACHINERY IS NOT POSSIBLE. MARK TREES ALONG LIMIT OF CLEARING WITH FLAGGING RIBBON OR PAINT CORRESPONDING TO THE CLEARING LIMITS ON EPSC PLAN. SPACING BETWEEN RIBBON OR PAINT MARKINGS SHALL BE NO MORE THAN 50 FEET.


BARRIER TAPE/ROPE: FOR USE WHERE PROPOSED DISTURBANCE BORDERS NON-WOODED, VEGETATED AREAS MORE THAN 100 FEET FROM THE NEAREST WATER RESOURCE (STREAM, BROOK, LAKE, POND, WETLAND, ETC.). BARRIER TAPE SHALL BE HIGH VISIBILITY FIBERGLASS TAPE WITH A MINIMUM WIDTH OF 3 INCHES. BARRIER TAPE SHOULD BE ATTACHED TO STAKES, AT A MINIMUM HEIGHT OF 4 FEET FROM THE GROUND.

CONSTRUCTION FENCE/SNOW FENCE/BOULDERS: FOR USE WHERE THE PROPOSED DISTURBANCE IS WITHIN 100 FEET OF A WATER RESOURCE (STREAM, BROOK, LAKE, POND, WETLAND, ETC.), UNLESS AREA IS DENSELY WOODED. FENCE SHOULD BE CONTINUOUS AND PREVENT ACCESS TO BUFFER AREAS BY MACHINERY. BOULDER SHALL BE SPACED CLOSELY TO PREVENT MACHINERY ACCESS.

EMPORARY CHAIN-LINK FENCE: FOR USE WHERE PROPOSED DISTURBANCE IS IN CLOSE PROXIMITY TO WETLANDS (AS SHOWN ON EPSC PLANS). FENCE SHALL BE INSTALLED DIRECTLY ON DELINEATION OF WETLAND TO ENSURE THERE IS NO DISTURBANCE TO THE WETLAND. TEMPORARY CHAIN-LINK FENCE SHALL BE INSTALLED ALONG WITH SILT FENCE APPROXIMATELY 6-INCHES ON PROJECT SIDE.

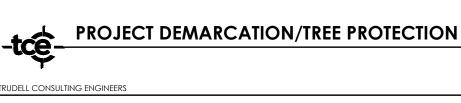

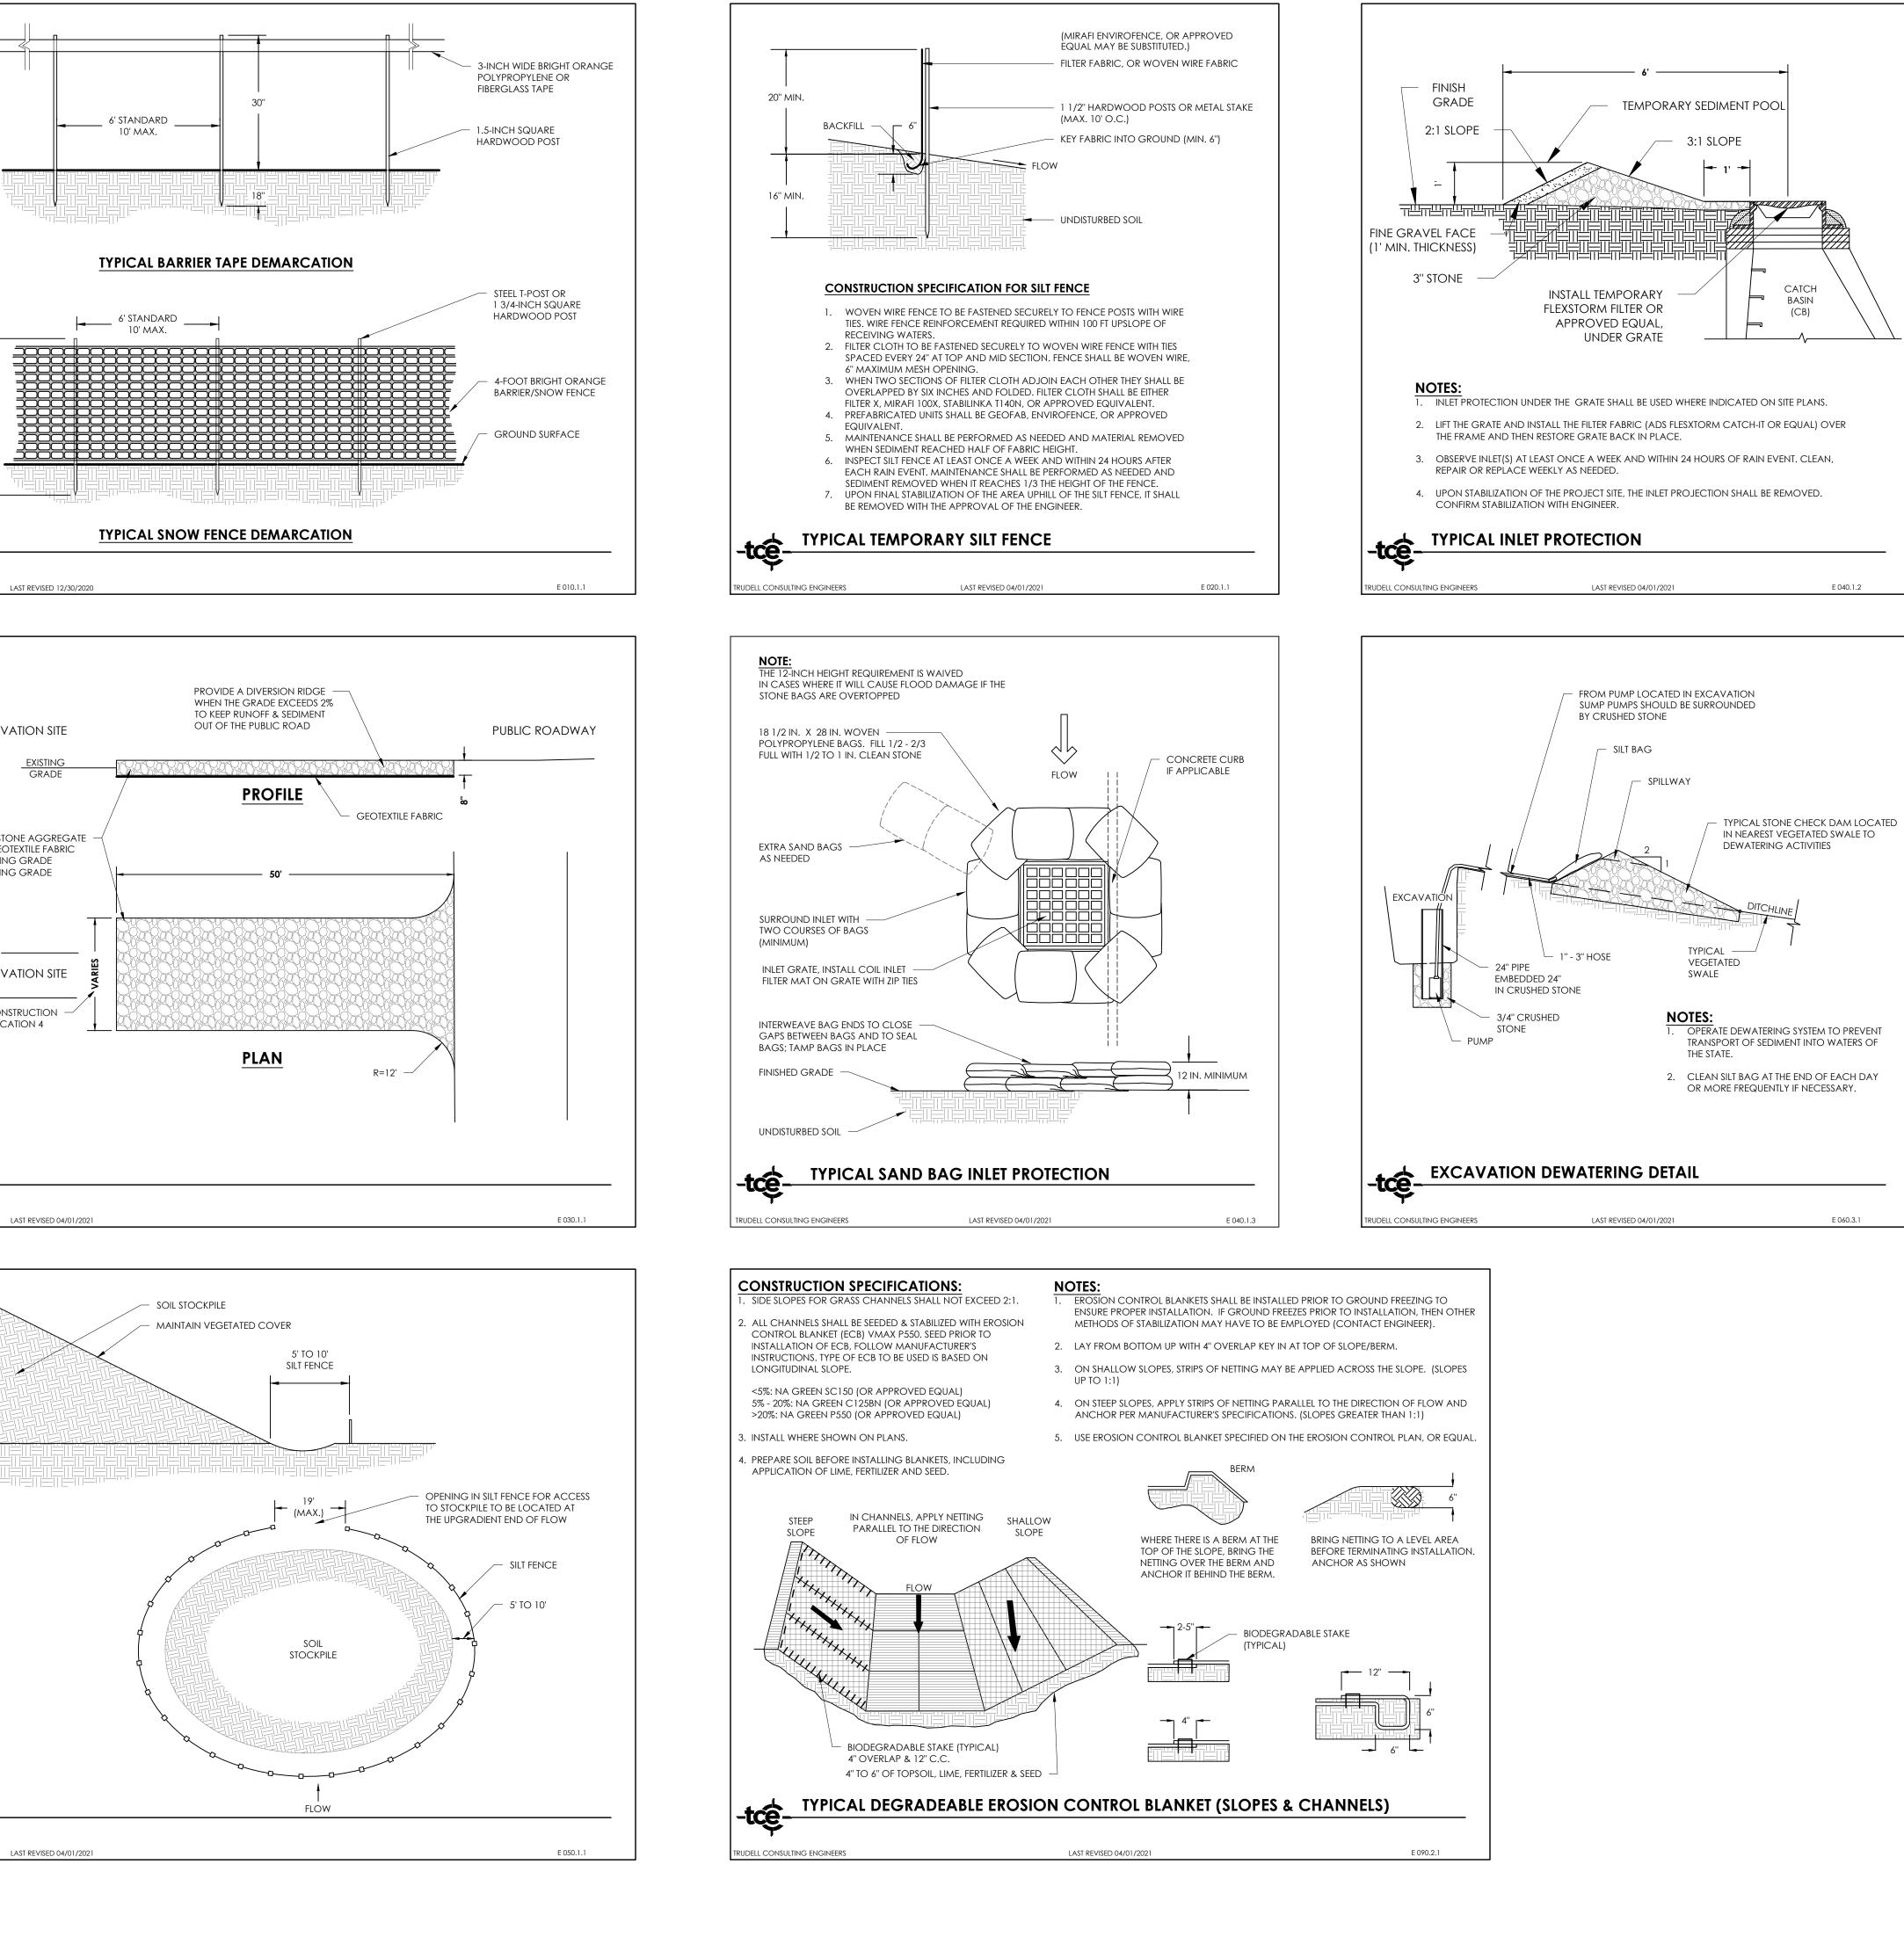

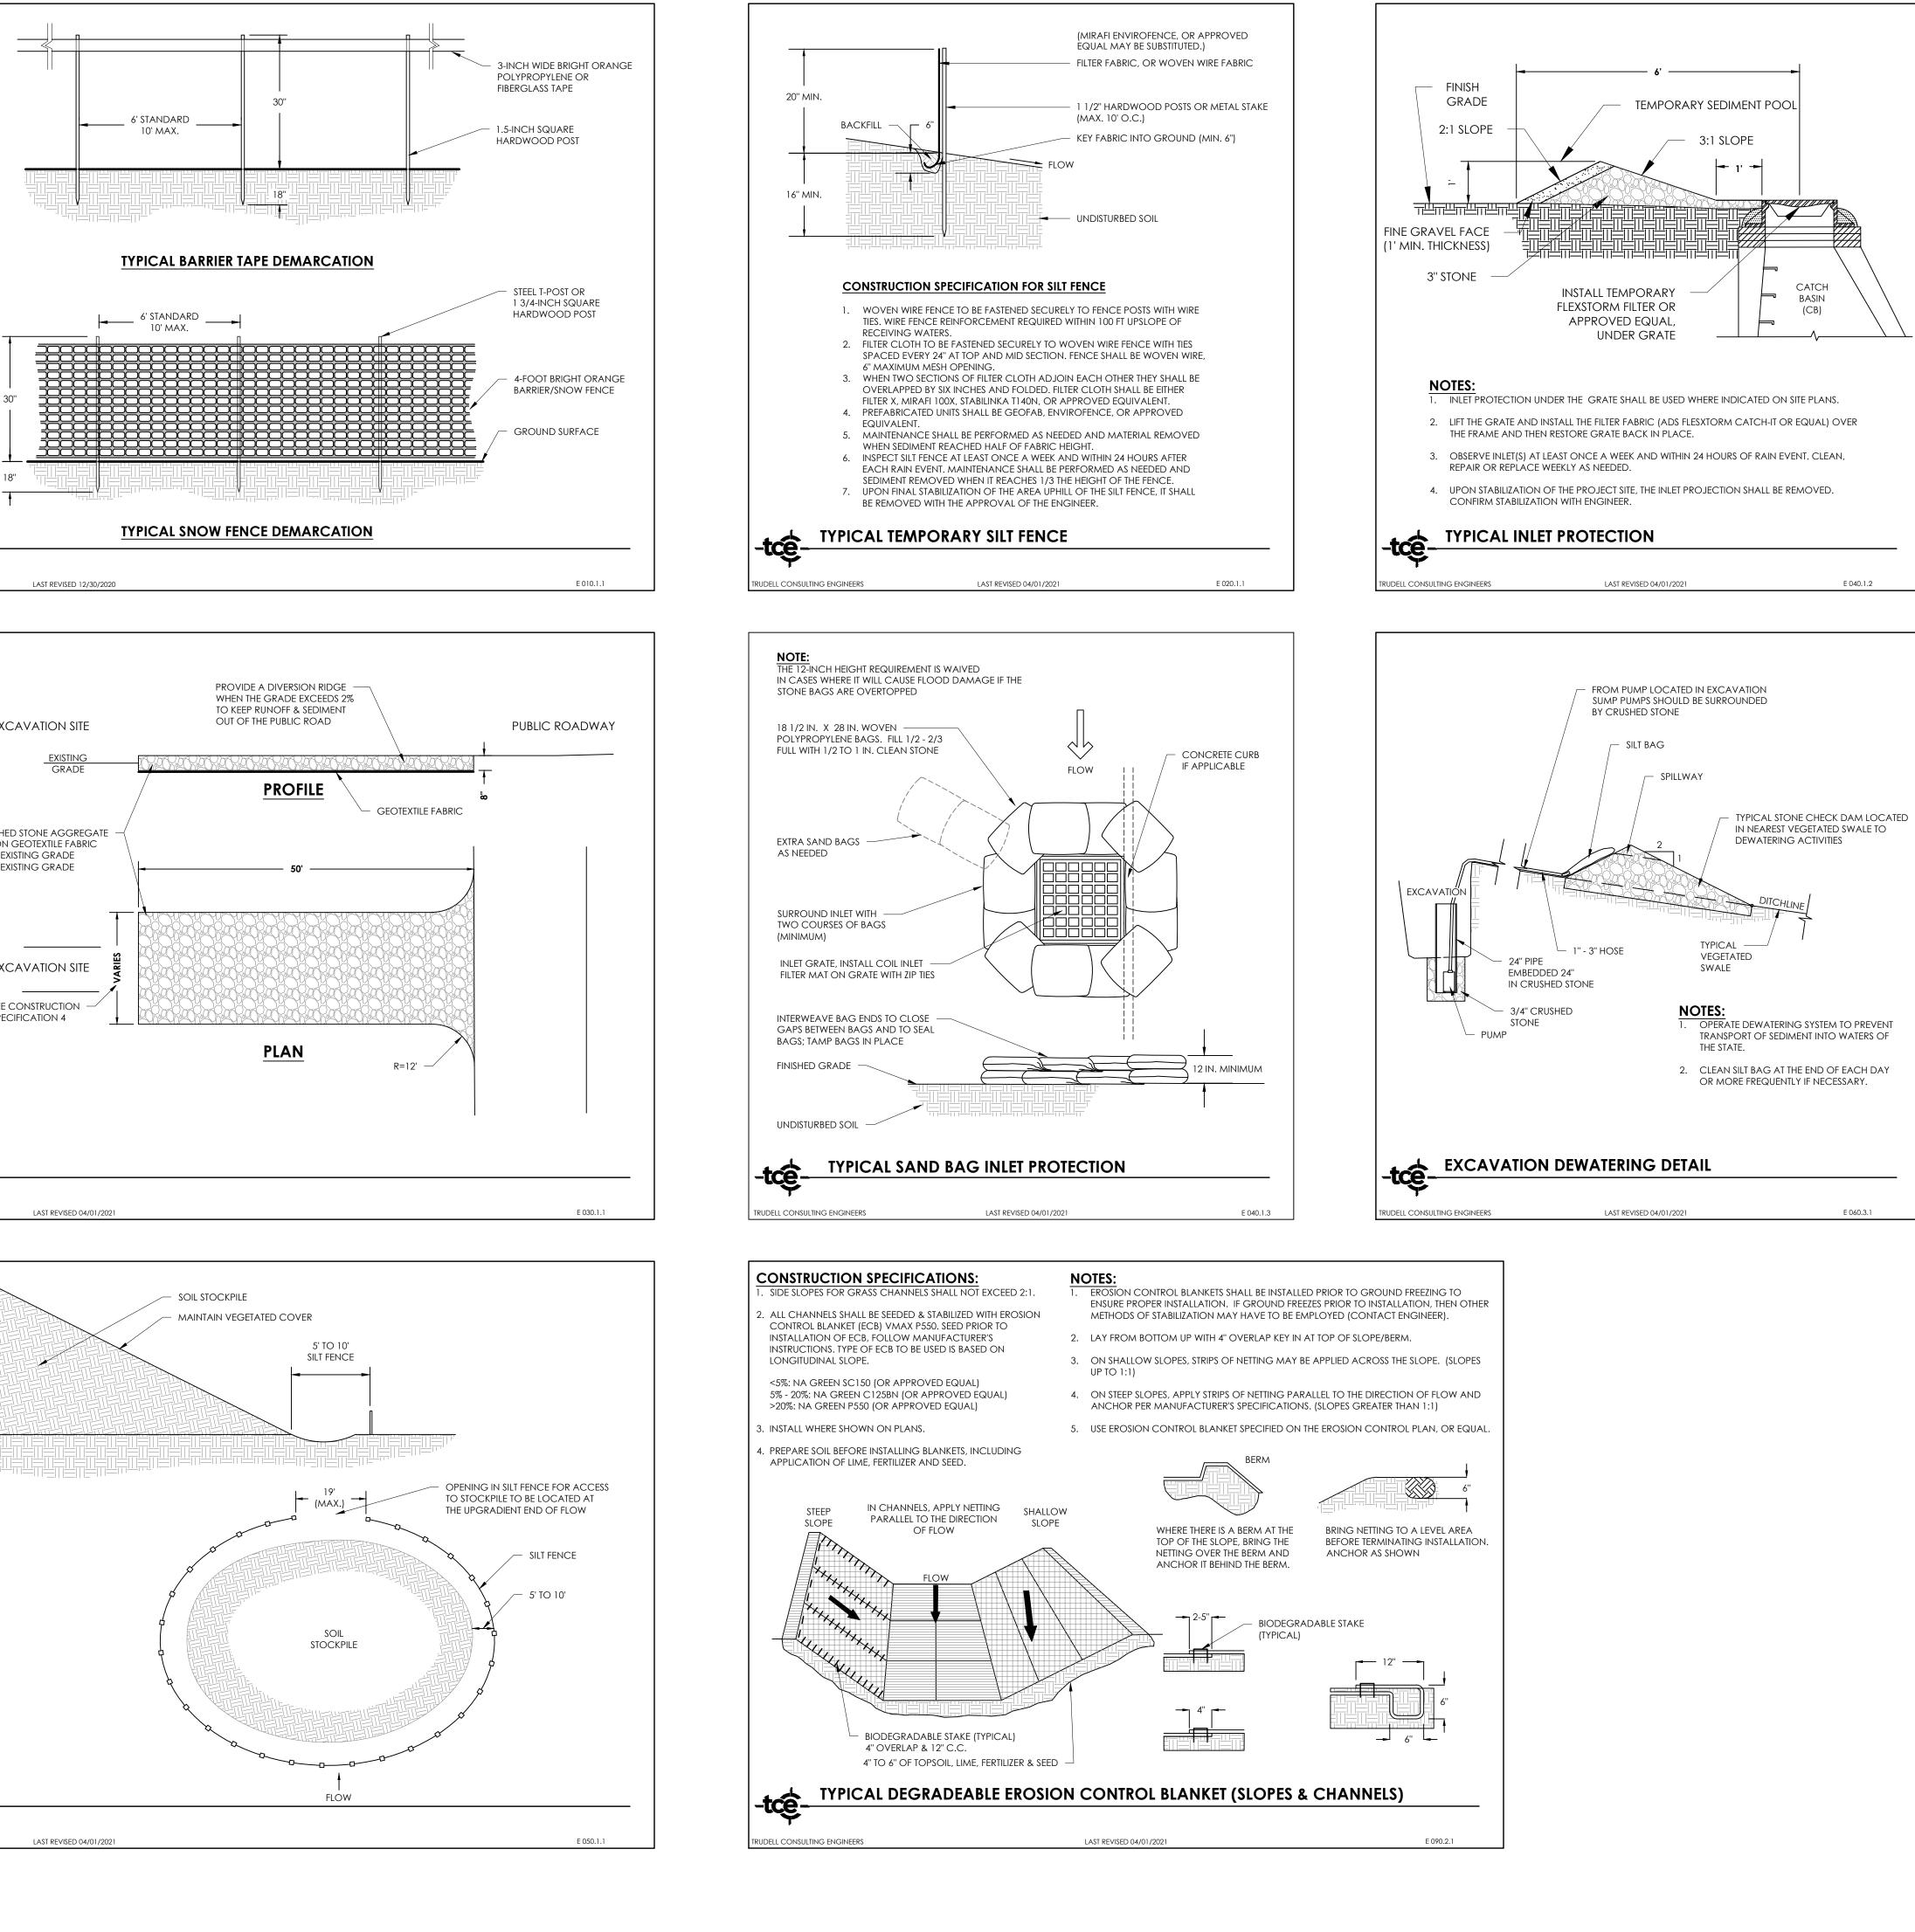

**EXCAVATION SITE** 4-8" CRUSHED STONE AGGREGATE PLACED ON GEOTEXTILE FABRIC 4" ABOVE EXISTING GRADE 4" BELOW EXISTING GRADE **EXCAVATION SITE** SEE CONSTRUCTION -SPECIFICATION 4



- STONE SIZE USE 4-8" CRUSHED STONE, OR RECLAIMED OR RECYCLED CONCRETE EQUIVALENT. 2. LENGTH - NOT LESS THAN 50' (EXCEPT ON A SINGLE RESIDENCE LOT WHERE A 30' MINIMUM LENGTH APPLIES).
- 3. THICKNESS NOT LESS THAN 8". 4. WIDTH - TWELVE (12) FOOT MINIMUM, BUT NOT LESS THAN THE
- FULL WIDTH AT POINTS WHERE INGRESS OR EGRESS OCCURS. TWENTY-FOUR (24) FOOT IF SINGLE ENTRANCE TO SITE.
- 5. GEOTEXTILES MUST BE PLACED OVER THE ENTIRE AREA PRIOR TO PLACING OF STONE.
- 6. SURFACE WATER ALL SURFACE WATER FLOWING OR DIVERTED TOWARDS CONSTRUCTION ENTRANCES SHALL BE PIPED BENEATH THE ENTRANCE. IF PIPING IS IMPRACTICAL, A MOUNTABLE BERM WITH 5:1 SLOPES WILL BE PERMITTED. 7. MAINTENANCE - THE ENTRANCE SHALL BE MAINTAINED IN A
- CONDITION WHICH WILL PREVENT TRACKING OR FLOWING OF SEDIMENT ONTO PUBLIC RIGHTS-OF-WAY, ALL SEDIMENT SPILLED, DROPPED, WASHED OR TRACKED ONTO PUBLIC RIGHTS-OF-WAY MUST BE REMOVED IMMEDIATELY AND DISPOSED OF IN ACCORDANCE WITH THE EPSC PLANS. (i.e. PLACED IN A SOIL STOCKPILE OR AREA WHERE IT CAN BE STABILIZED PER EPSC DETAILS). IF SWEEPING IS THE CHOSEN METHOD FOR REMOVAL THE SWEPT MATERIAL MUST BE COLLECTED AND DISPOSED OF AS STATED ABOVE.
- 8. WHEN WASHING IS REQUIRED, IT SHALL BE DONE ON AN AREA STABILIZED WITH STONE AND WHICH DRAINS INTO AN APPROVED SEDIMENT TRAPPING DEVICE.
- 9. PERIODIC INSPECTION AND NEEDED MAINTENANCE SHALL BE PROVIDED ACCORDING TO PERMIT REQUIREMENTS BASED ON SITE CONDITIONS, WEATHER AND FLOW OF TRAFFIC.


### STABILIZED CONSTRUCTION ENTRANCE



-tce

TEMPORARY SEED & MULCH -5' TO 10' SILT FENCE - INSTALL SHALLOW TRENCH AROUND MOUND 1. INSTALL SILT FENCE ALONG CONTOUR ON DOWNSLOPE SIDE OF STOCKPILE. COMPLETELY ENCLOSE STOCKPILE ON FLAT SITES. SILT FENCE TO REMAIN IN PLACE UNTIL MATERIAL IS REMOVED AND AREA IS STABILIZED. 2. A MINIMUM OF 5' SEPARATION BETWEEN THE TOE OF THE STOCKPILE SLOPE AND THE SILT FENCE IS REQUIRED AT ALL TIMES TEMPORARY SOIL STOCKPILE EROSION PROTECTION -tce

DELL CONSULTING ENGINEER:

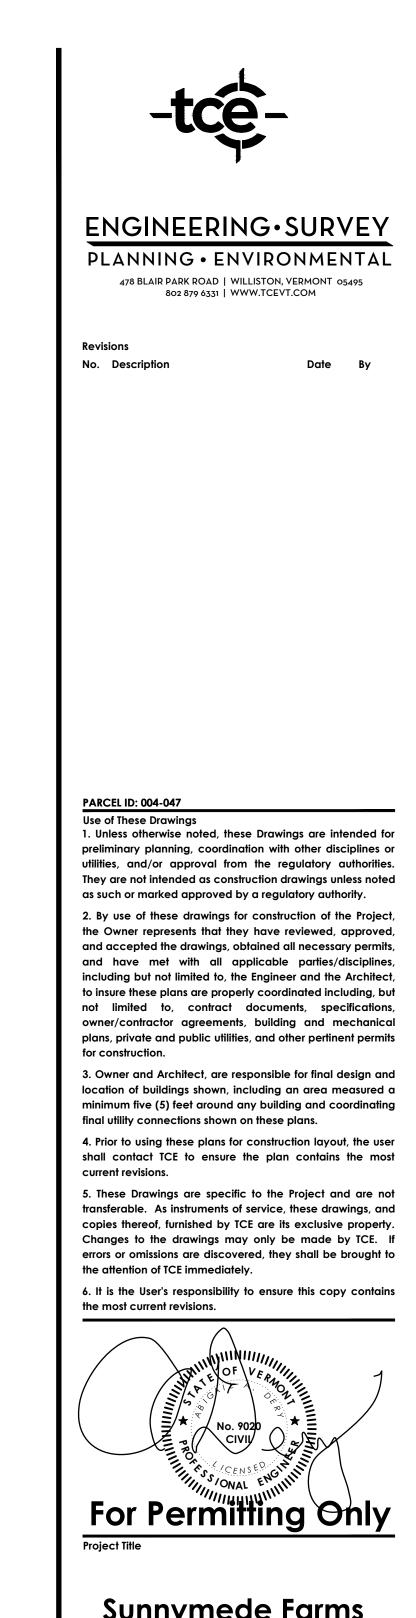

Sunnymede Farms


Store 88 US 5 Hartland, Vermont

Sheet Title

## **EPSC Details**

Date:	5/18/2022
Scale:	
Project Number:	21-358
Drawn By:	СМЈ
Project Engineer:	СМЈ
Approved By:	AAD
Field Book:	360, 364

C8-10

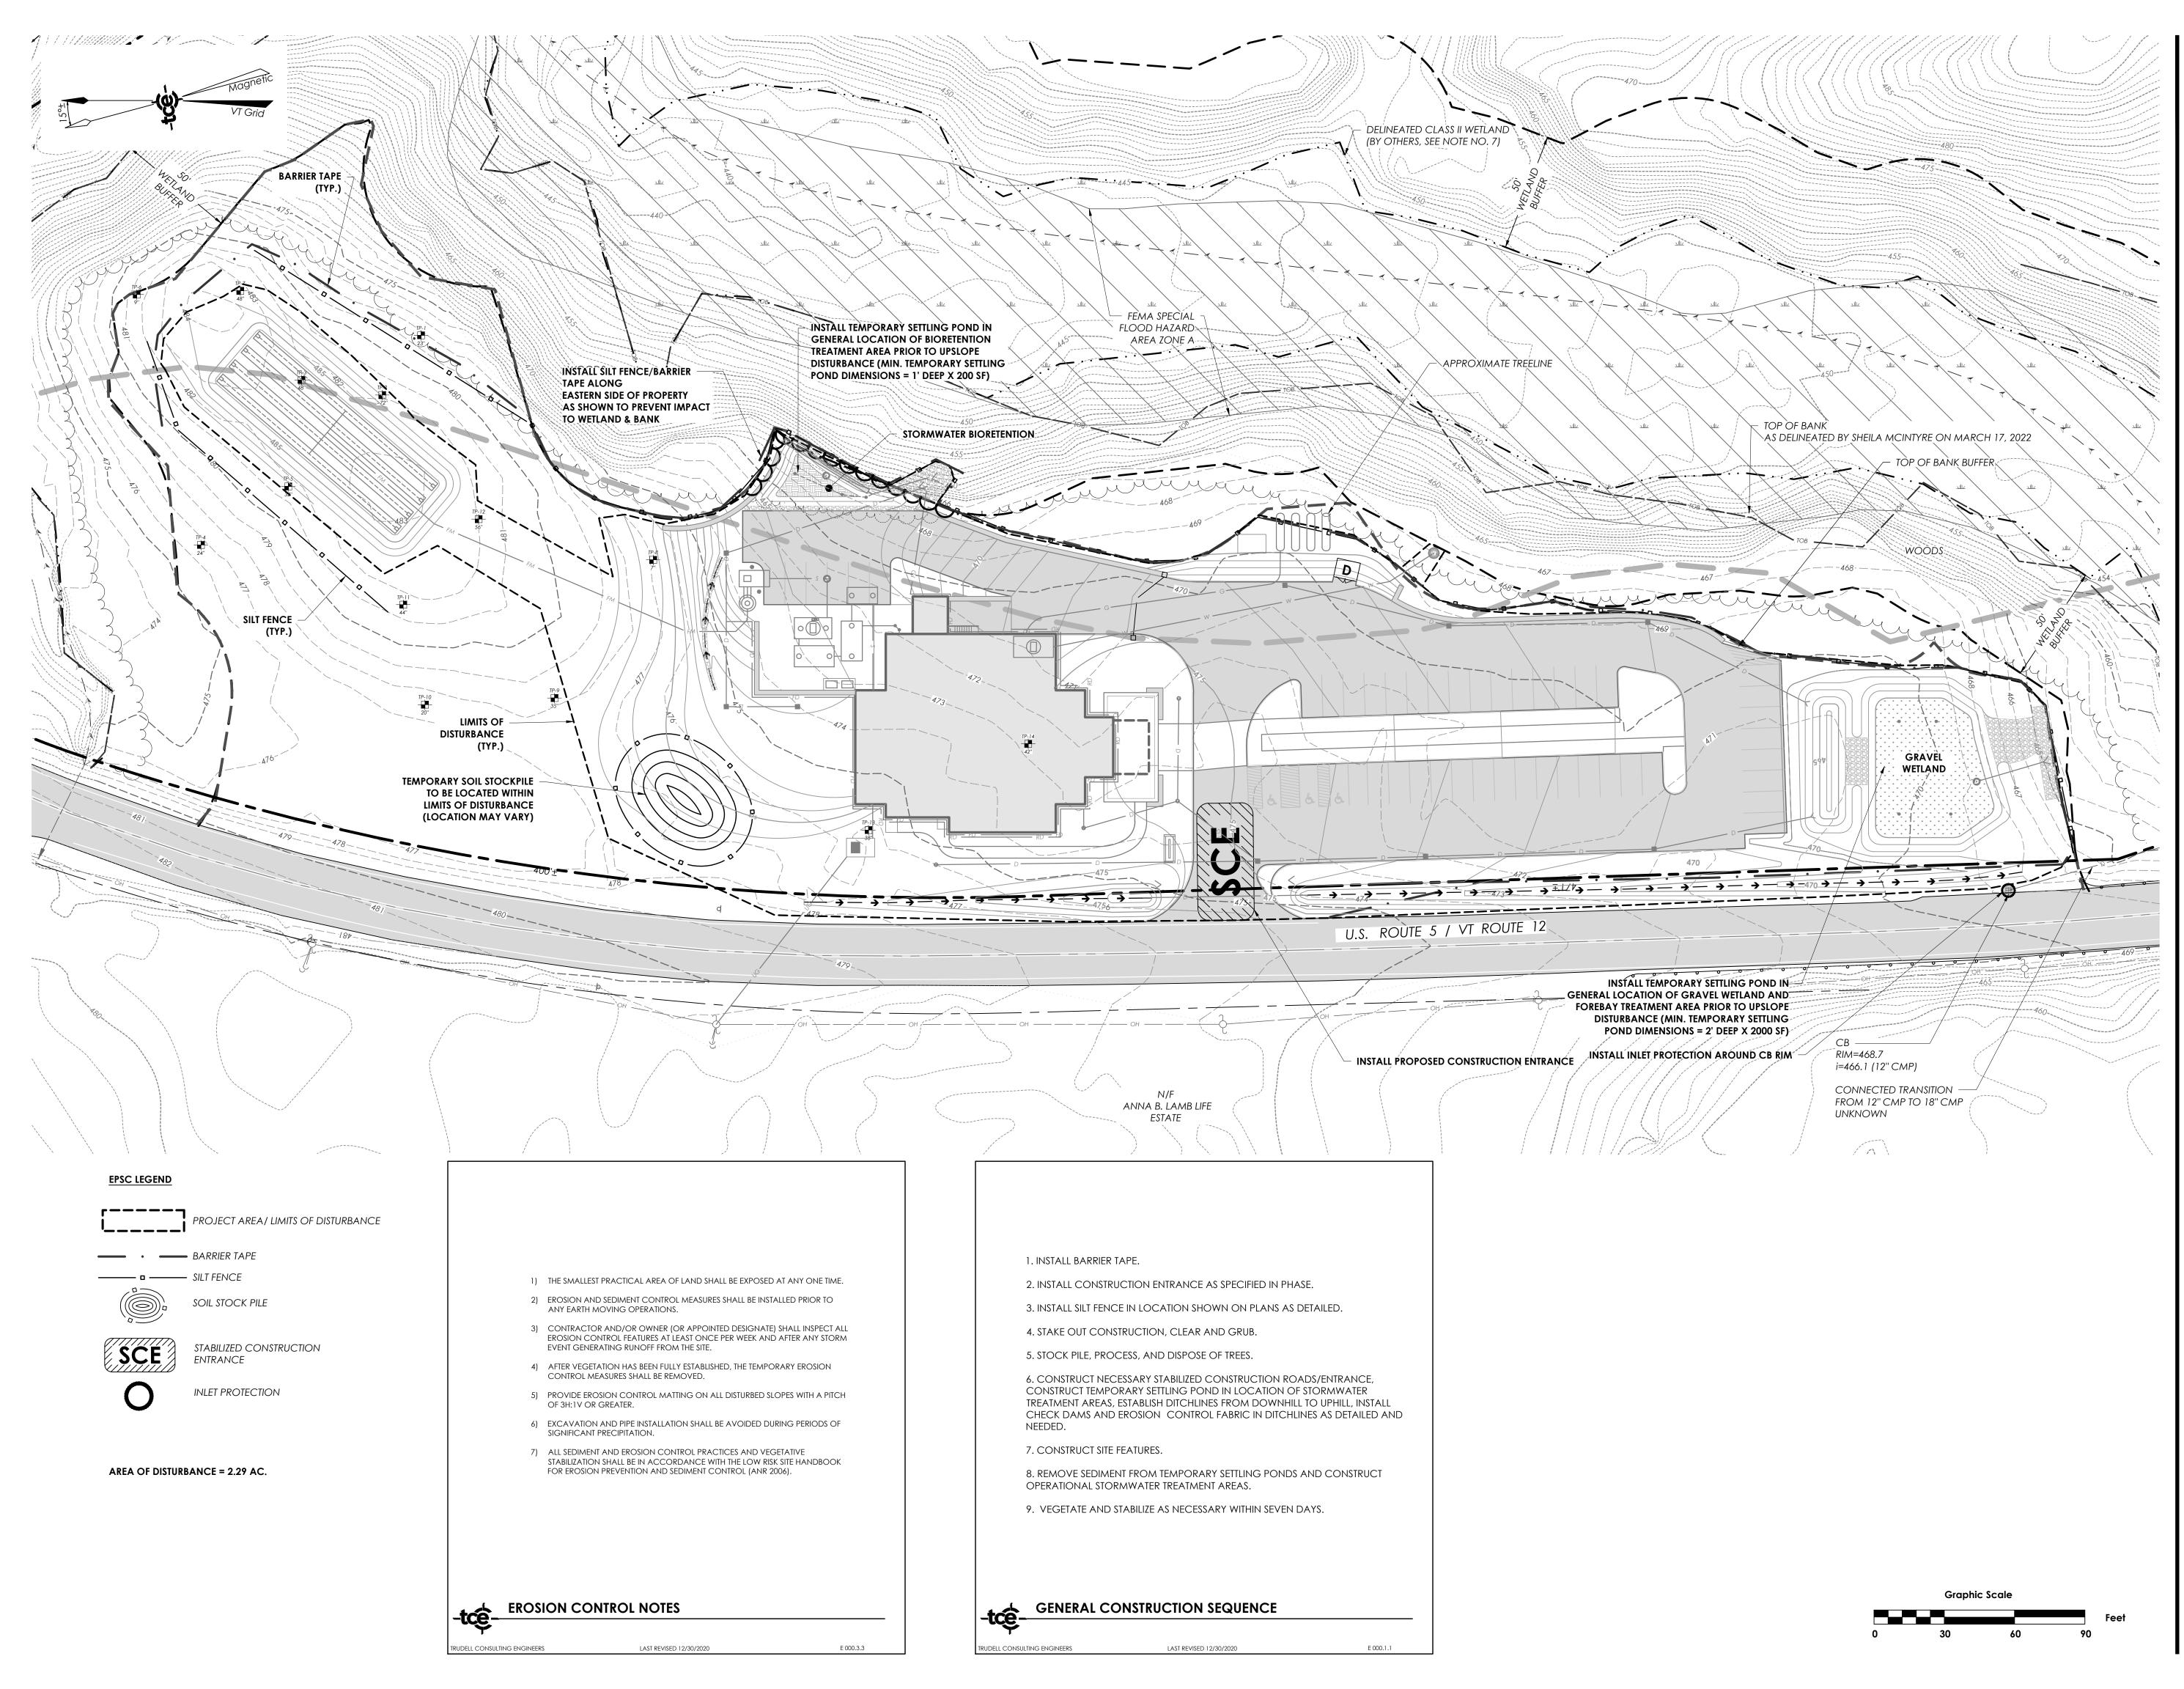



# ENGINEERING·SURVEY

PLANNING • ENVIRONMENTAL 478 BLAIR PARK ROAD | WILLISTON, VERMONT 05495 802 879 6331 | WWW.TCEVT.COM

Revisions No. Description Revisions for Wastewater Permitting

**Date By** 

#### PARCEL ID: 004-047 Use of These Drawings

1. Unless otherwise noted, these Drawings are intended for preliminary planning, coordination with other disciplines or utilities, and/or approval from the regulatory authorities. They are not intended as construction drawings unless noted as such or marked approved by a regulatory authority.


2. By use of these drawings for construction of the Project, the Owner represents that they have reviewed, approved, and accepted the drawings, obtained all necessary permits, and have met with all applicable parties/disciplines, including but not limited to, the Engineer and the Architect, to insure these plans are properly coordinated including, but not limited to, contract documents, specifications, owner/contractor agreements, building and mechanical plans, private and public utilities, and other pertinent permits for construction.

3. Owner and Architect, are responsible for final design and location of buildings shown, including an area measured a minimum five (5) feet around any building and coordinating final utility connections shown on these plans.

4. Prior to using these plans for construction layout, the user shall contact TCE to ensure the plan contains the most current revisions.

5. These Drawings are specific to the Project and are not transferable. As instruments of service, these drawings, and copies thereof, furnished by TCE are its exclusive property. Changes to the drawings may only be made by TCE. If errors or omissions are discovered, they shall be brought to the attention of TCE immediately.

6. It is the User's responsibility to ensure this copy contains the most current revisions.

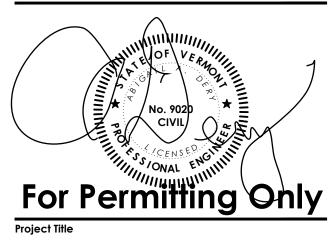

## Sunnymede Farms


Store 88 US 5 Hartland, Vermont

Sheet Title

## **EPSC Plan**

Date:	5/18/2022
Scale:	1'' = 30'
Project Number:	21-358
Drawn By:	AAD/CMJ
Project Engineer:	СМЈ
Approved By:	AAD
Field Book:	360, 364
HEIG BOOK.	



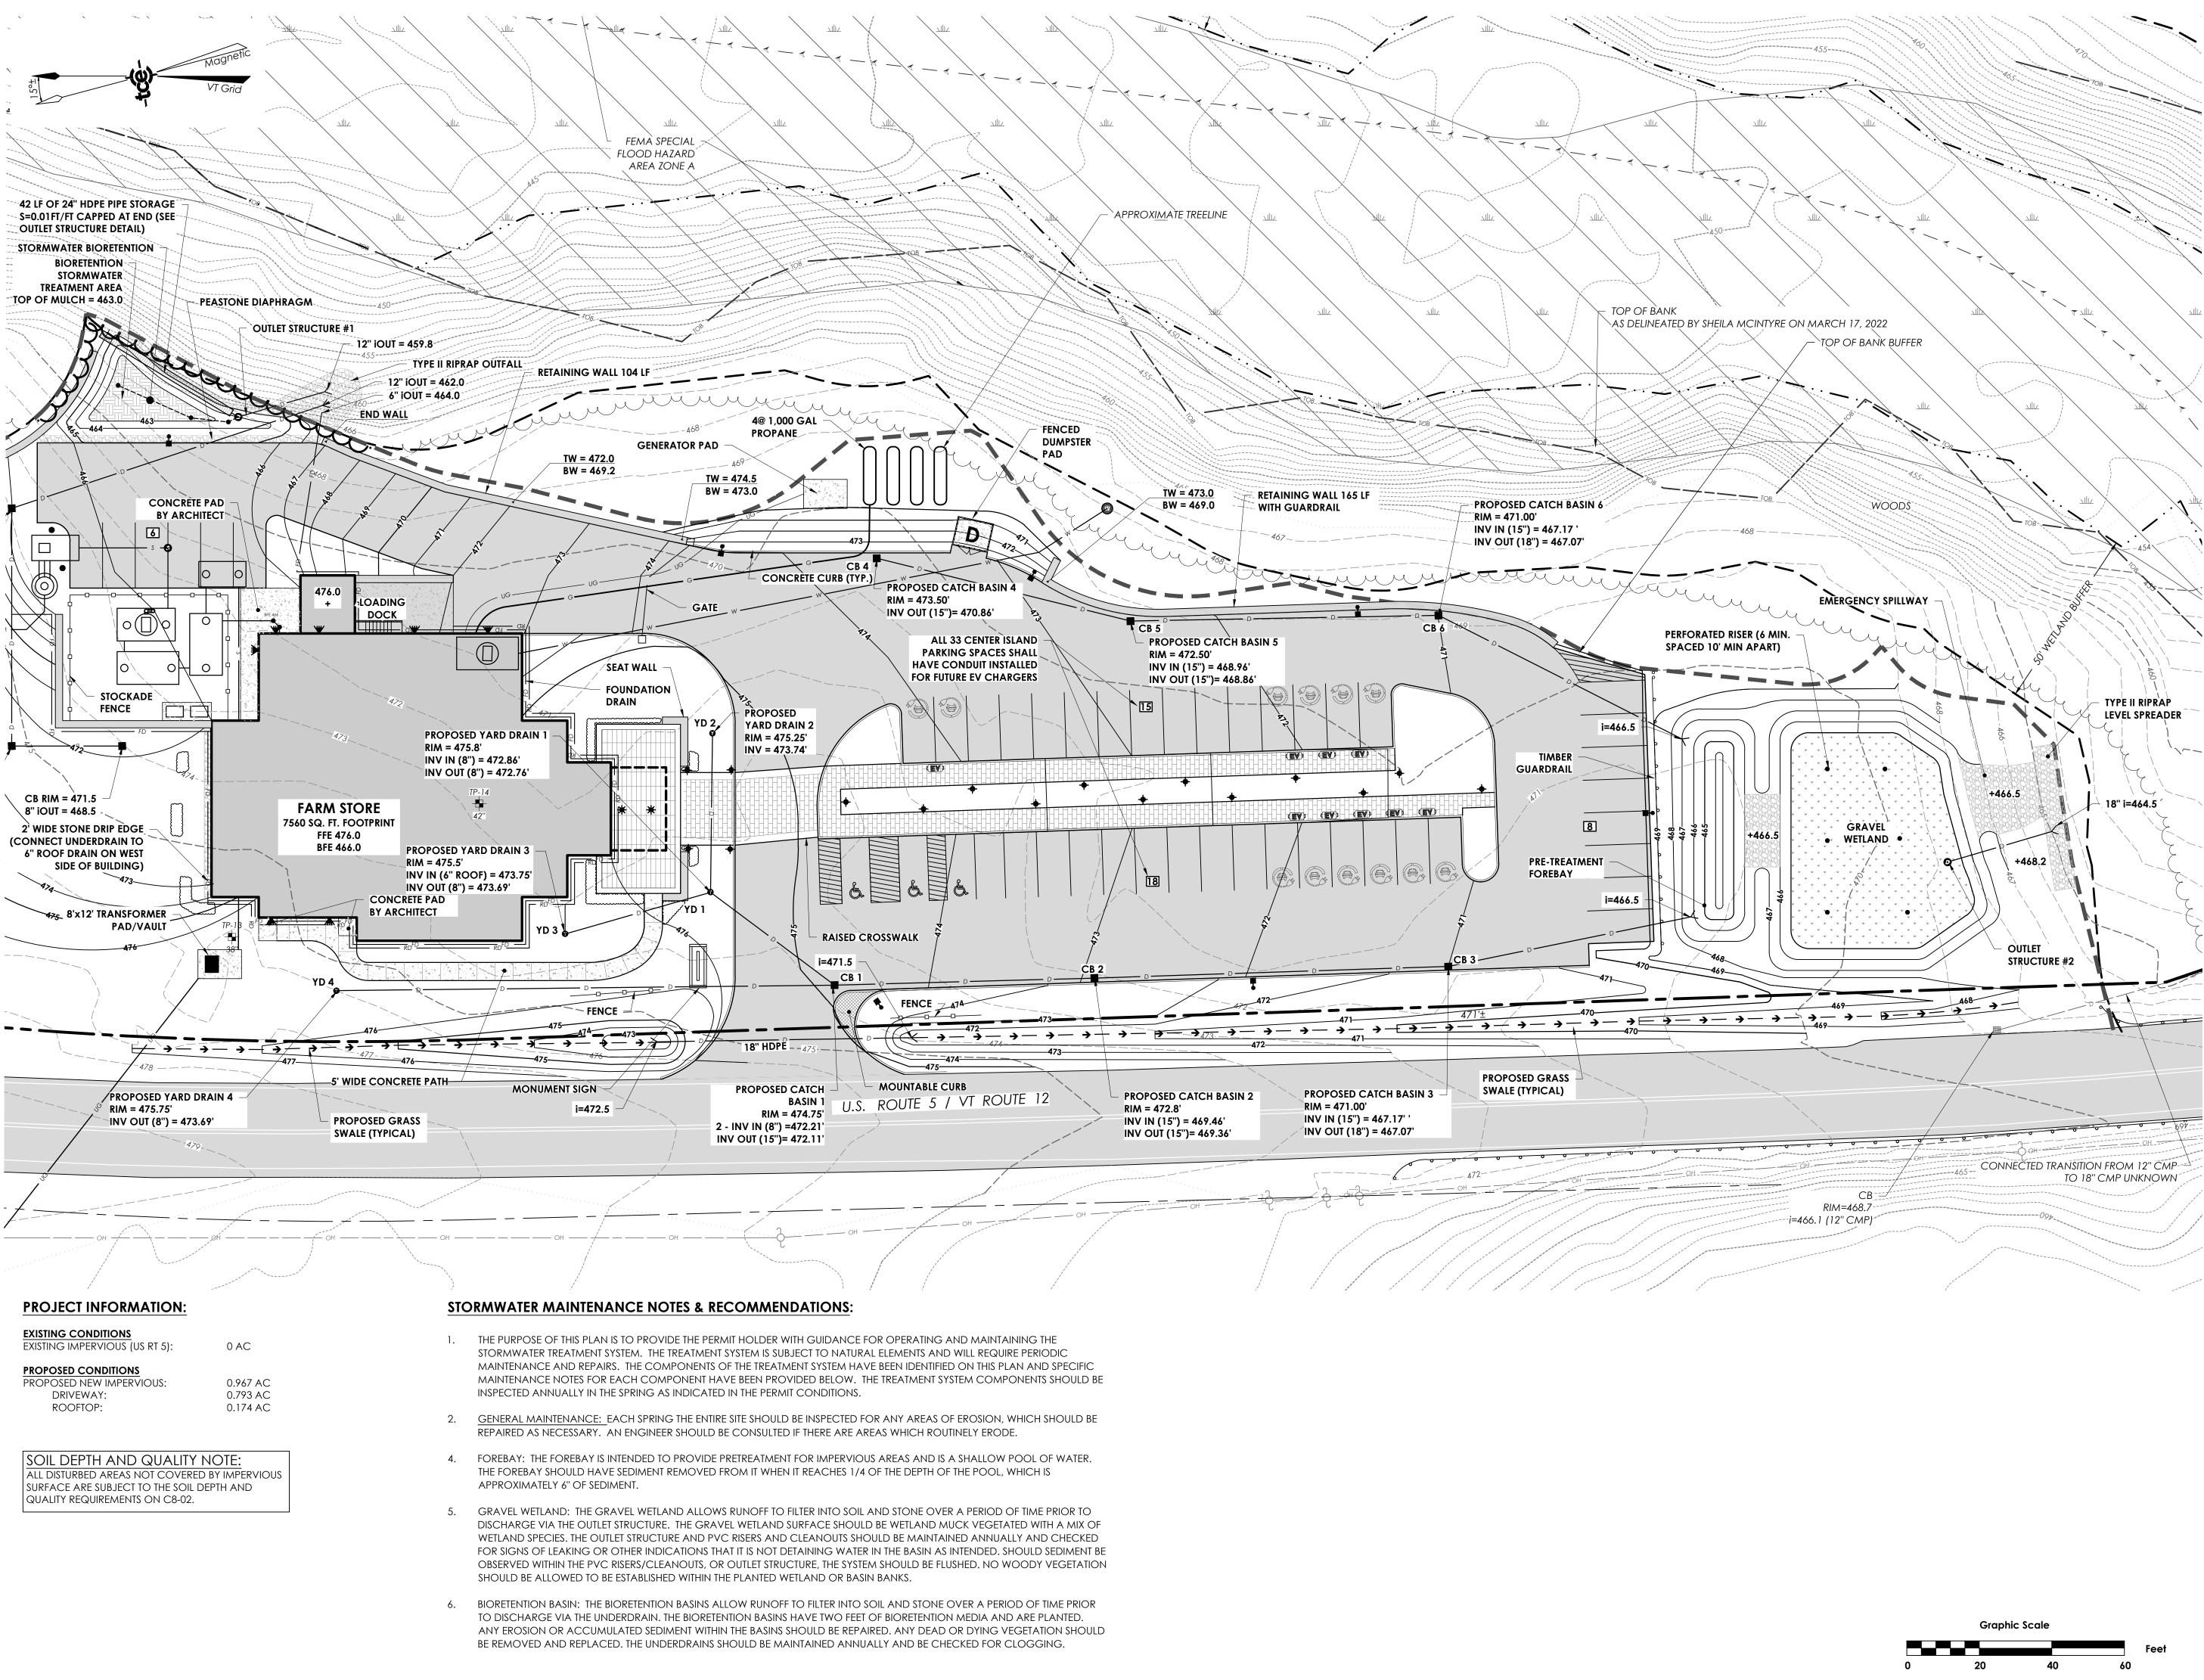



# **ENGINEERING**•SURVEY

**PLANNING • ENVIRONMENTAL** 478 BLAIR PARK ROAD | WILLISTON, VERMONT 05495 802 879 6331 | WWW.TCEVT.COM

Revision No. Descriptior Revisions tor Permitting Revisions for Wastewater

Date 05/27/2022 CMJ

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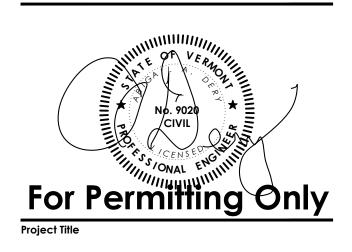
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Store 88 US 5 Hartland, Vermont

Sheet Title

## Site Plan

Date:	5/18/2022	
Scale:	1'' = 20'	
Project Number:	21-358	
Drawn By:	AAD/CMJ	
Project Engineer:	СМЈ	
Approved By:	AAD	
Field Book:	360, 364	

C2-02





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Revisions No. Description Revisions for Wastewater Permitting

**Date By** 

#### PARCEL ID: 004-047

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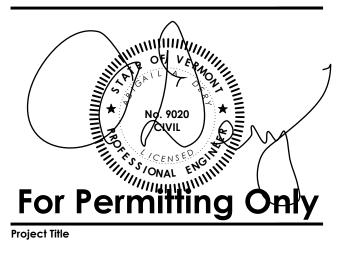
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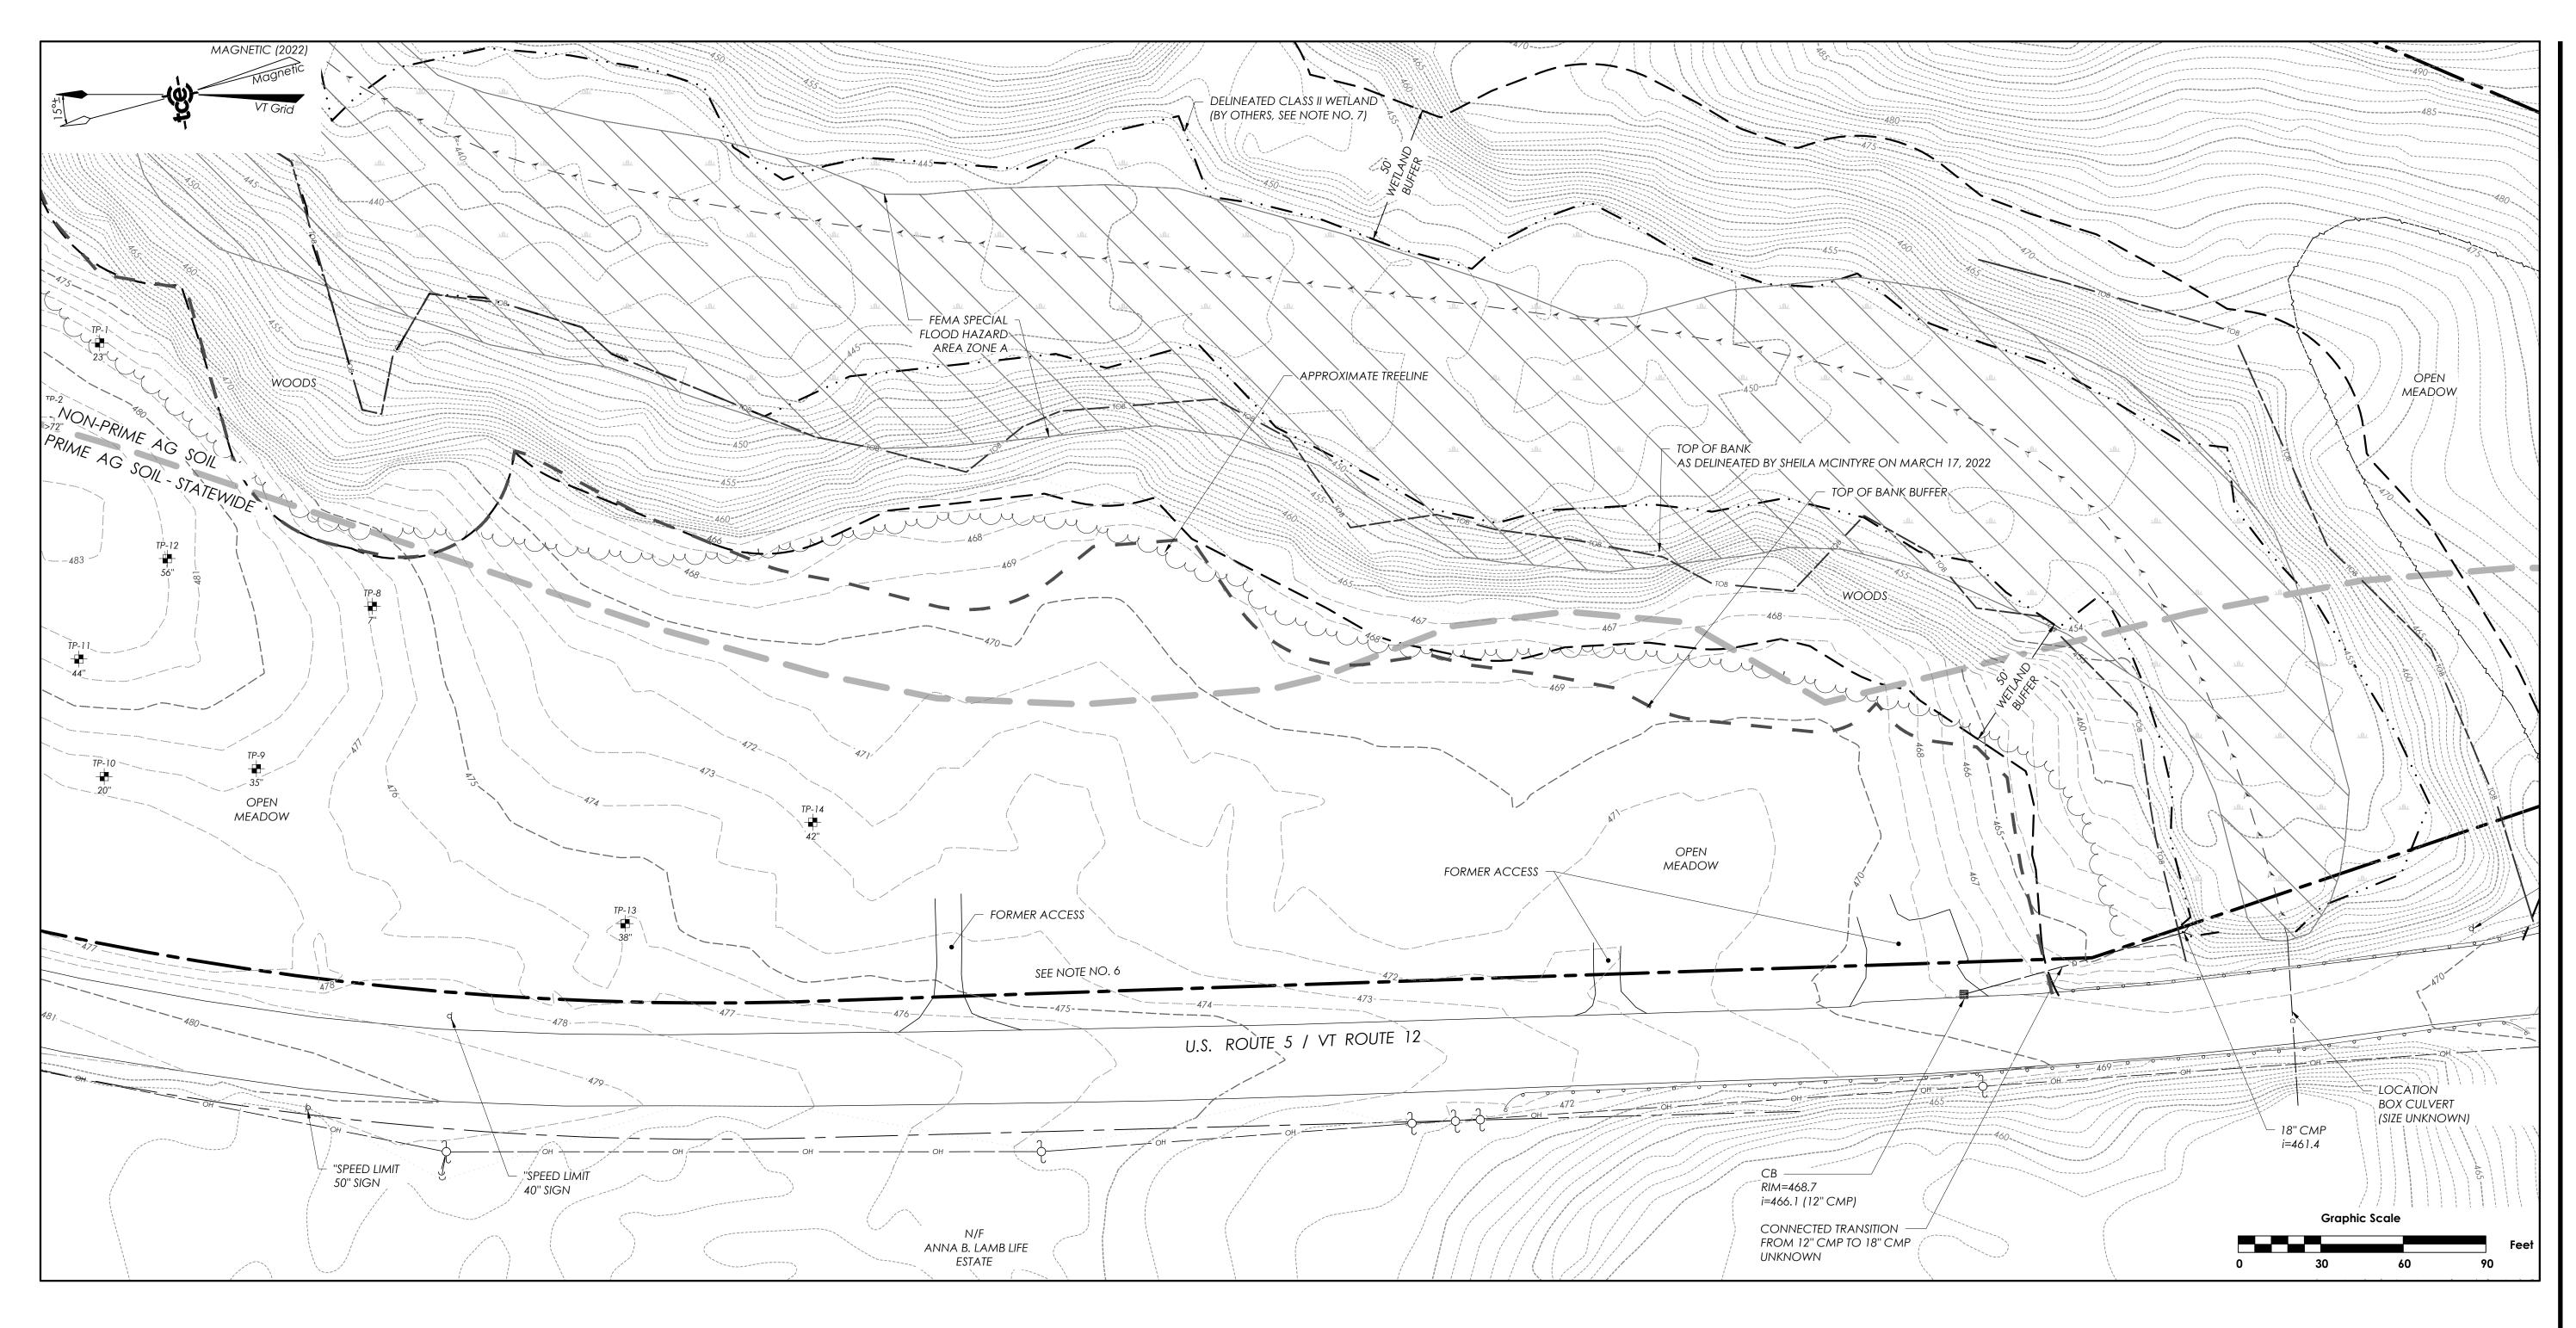
**Store** 88 US 5 Hartland, Vermont


Sheet Title

# **Overall Site Plan**

Date:	5/18/2022
Scale:	1'' = 50'
Project Number:	21-358
Drawn By:	AAD/CMJ
Project Engineer:	СМЈ
Approved By:	AAD
Field Book:	360, 364





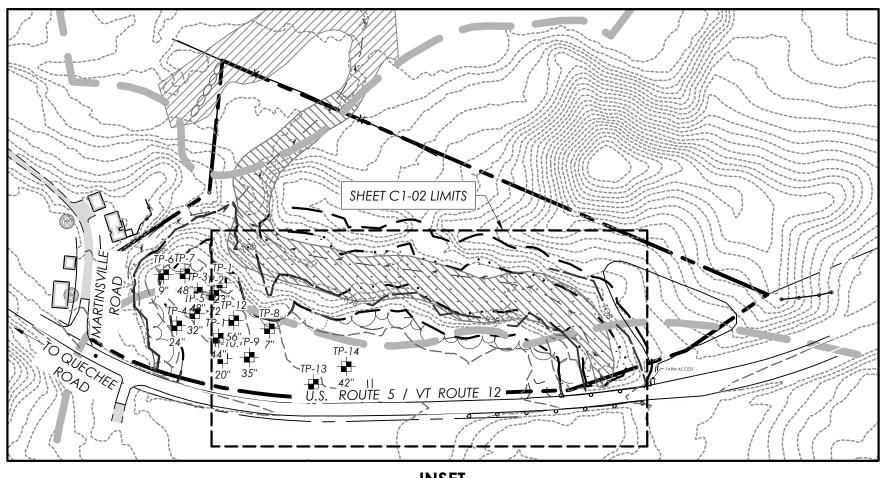

<u>INSET</u> SCALE: 1" = 200'

### **EXISTING CONDITIONS NOTES:**

- THE NSRS WERE NOT OBTAINED.

- DATED 02/08/2022.

1. THE PURPOSE OF THE EXISTING CONDITIONS PLAN IS TO DEPICT READILY APPARENT PERTINENT EXISTING CONDITIONS AS OF FEBRUARY 2022. PLAN IS BASED ON FIELD OBSERVATIONS BY TRUDELL CONSULTING ENGINEERS AND INFORMATION PROVIDED ELECTRONICALLY BY PATHWAYS CONSULTING, LLC.

2. BEARINGS SHOWN ARE BASED UPON VERMONT GRID NORTH USING VTVRS CORS STATION.

3. VERTICAL DATUM IS REFERENCED TO NAVD88 (GEOID 18) AS OBSERVED ON VTVRS REAL TIME NETWORK USING A CARLSON BRX7 GNSS RECEIVER AND CARLSON SURVPC SOFTWARE. LOCATIONS OF MONUMENTS TIED TO

4. COORDINATE SYSTEM IS BASED ON VERMONT STATE PLANE (U.S. SURVEY FEET).

5. THE LOCATION OF EXISTING UNDERGROUND UTILITIES AND IMPROVEMENTS SHOWN ARE BASED ON RESEARCH, UTILITY PLANS PROVIDED BY OTHERS, AND/OR SURFACE EVIDENCE ENCOUNTERED AND WERE OBTAINED IN A MANNER CONSISTENT WITH QUALITY LEVEL C (QL-C) AS DEFINED BY CI/ASCE 38-02, "STANDARD GUIDELINES FOR THE COLLECTION AND DEPICTION OF EXISTING SUBSURFACE UTILITY DATA" AND HAVE NOT BEEN INDEPENDENTLY VERIFIED BY THE OWNER OR THE DESIGN ENGINEER. ADDITIONAL UTILITIES NOT SHOWN MAY EXIST. ENGINEER SHALL BE NOTIFIED IF ANY DISCREPANCIES ARE ENCOUNTERED. ACTUAL LOCATION OF UNDERGROUND UTILITIES MAY VARY. DIGSAFE MUST BE CONTACTED PRIOR TO ANY EXCAVATION. CALL 1-888-DIG SAFE (344-7233) OR CALL 811.

6. PERIMETER BOUNDARIES SHOWN HEREON STRICTLY FROM SURVEY BY TRUDELL CONSULTING ENGINEERS ENTITLED "ALTA/NSPS LAND TITLE SURVEY SMFVTMGT, LLC PARCEL ID# 004047 88US5 HARTLAND, VERMONT"

7. THE WETLAND DELINEATION SHOWN ON THIS PLAN ARE BY OTHERS AND ARE BASED ON PLANS BY TIM MCCORMICK AT PATHWAYS CONSULTING, LLC., 2020. THE WETLAND DELINEATION WAS VERIFIED IN THE FIELD BY REBECCA CHALMERS, VT ANR WSMD, ON 5/05/2022.



### **ENGINEERING·SURVEY**

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Revisions		
No.	Description	I

Date By

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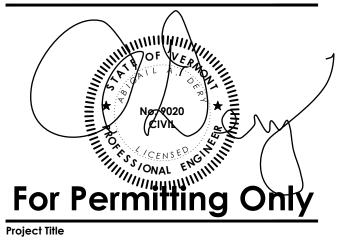
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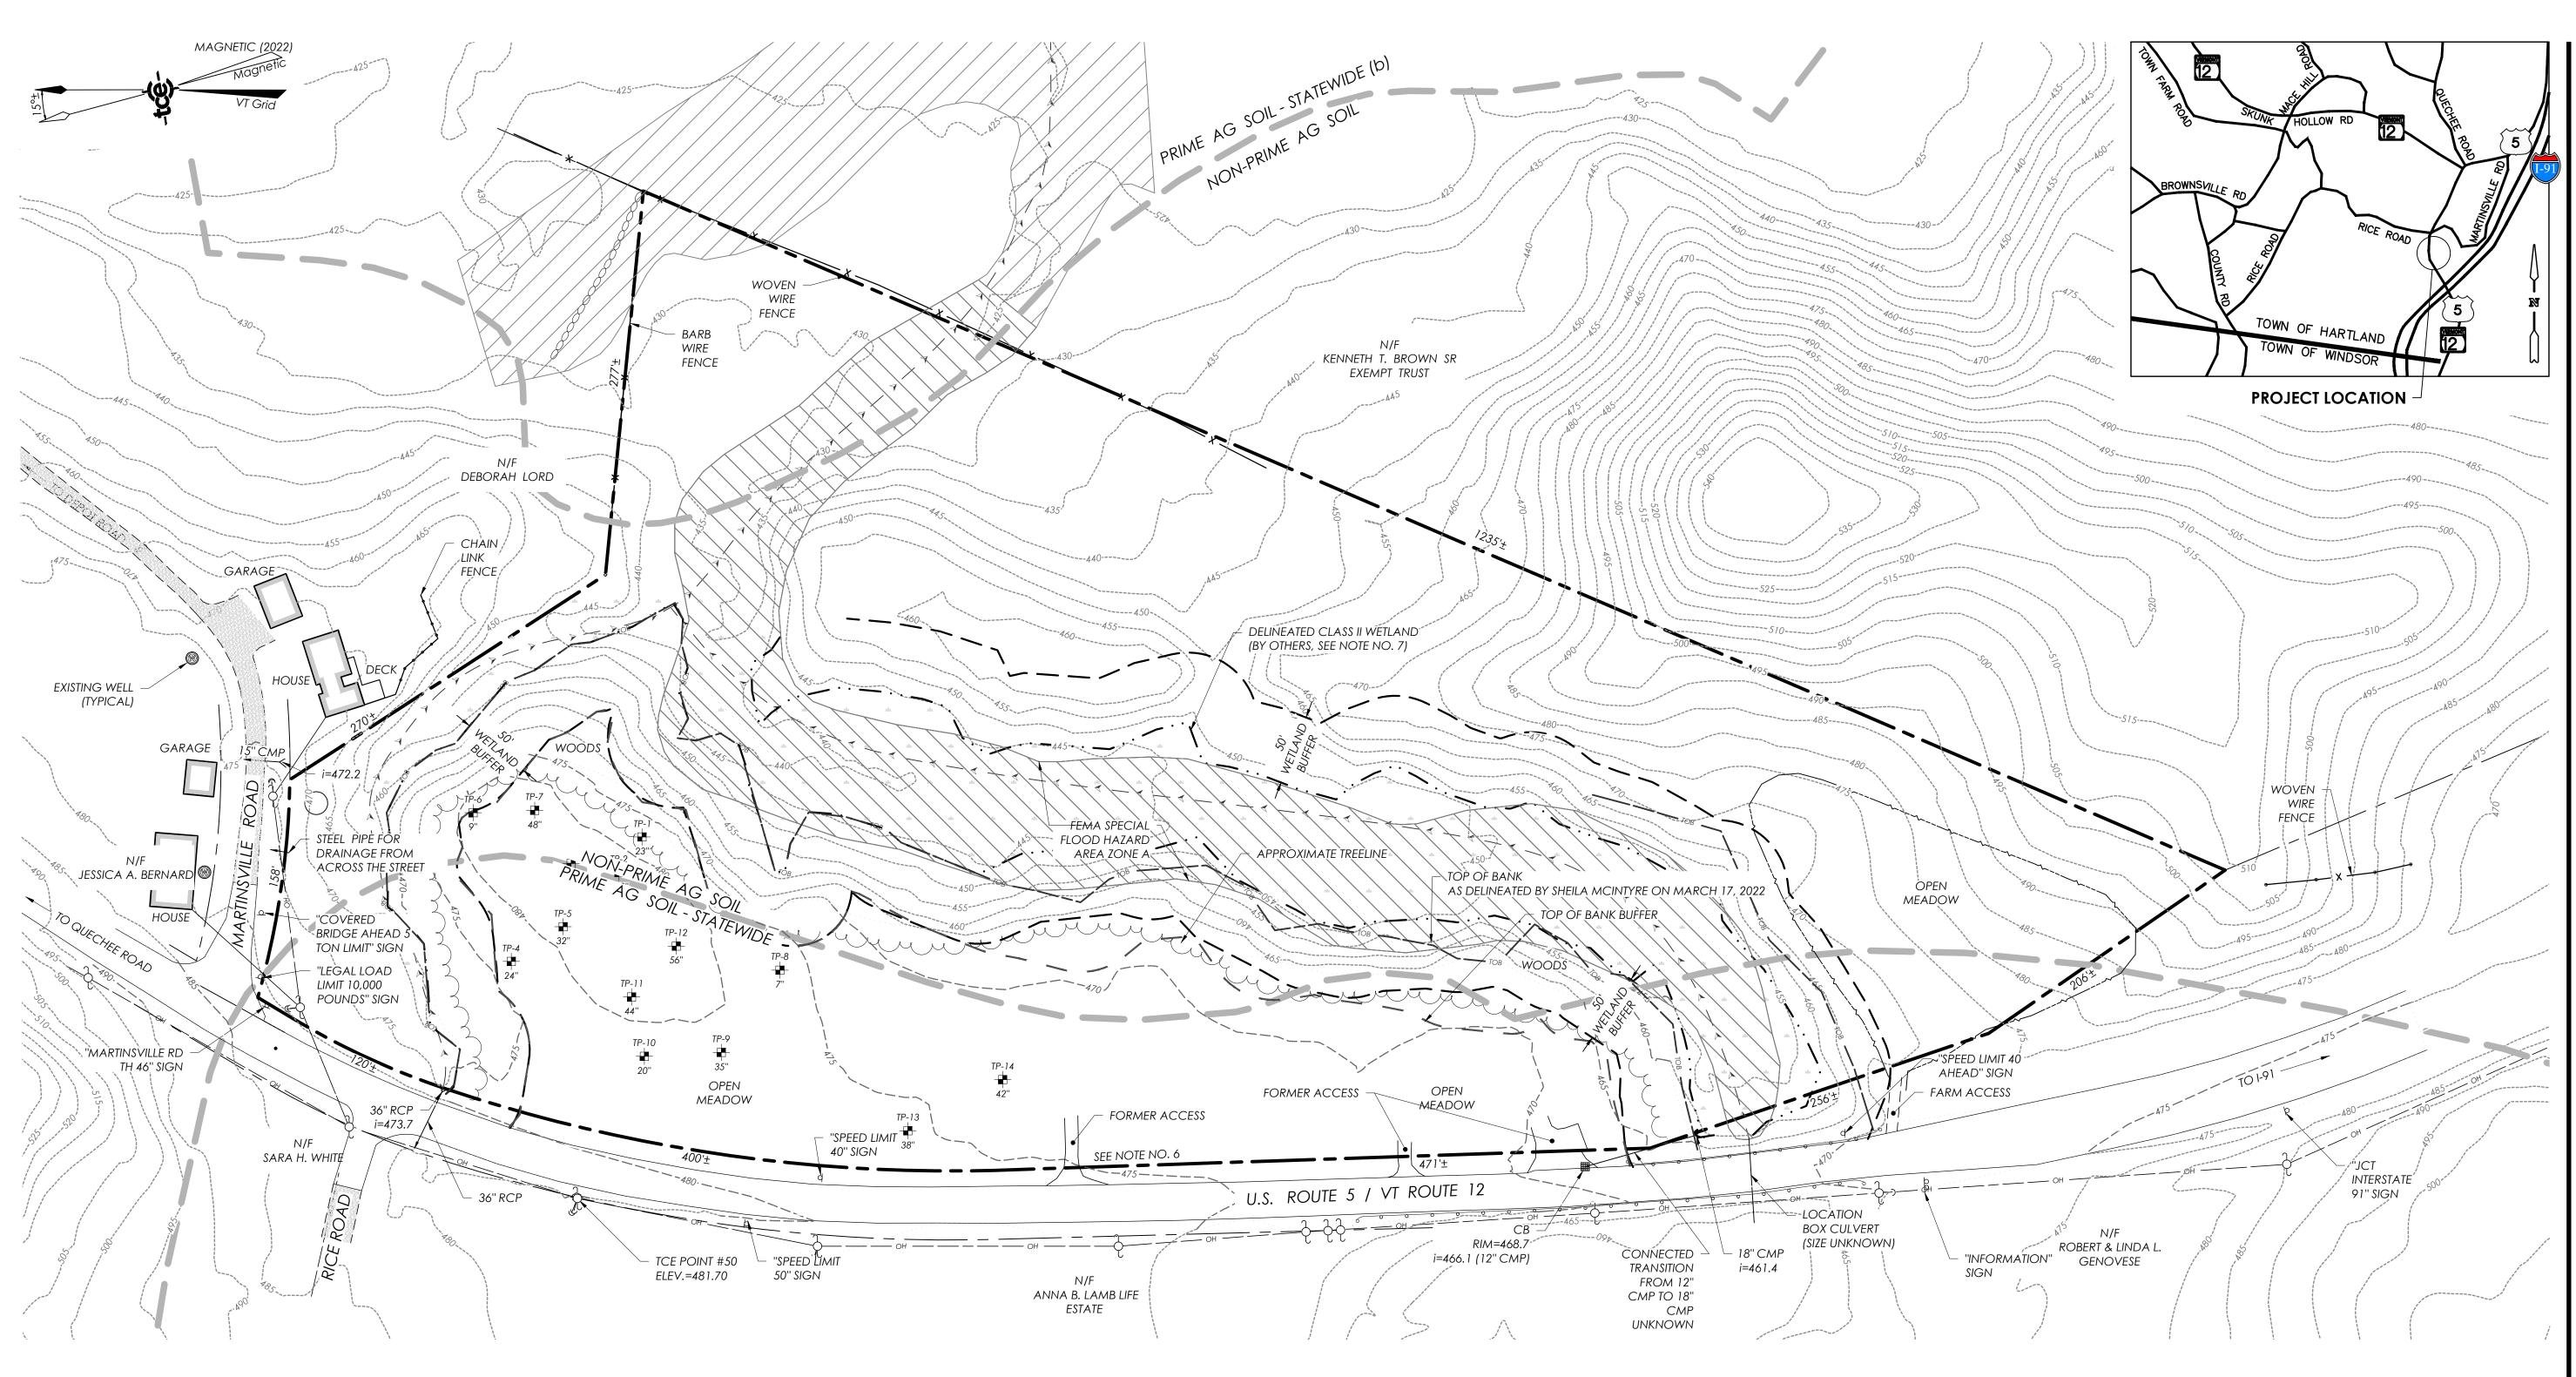
Store 88 US 5 Hartland, Vermont

# **Existing Conditions** Plan

Sheet Title

Date:	5/18/2022	
Scale:	1'' = 30'	
scale.		
Project Number:	21-358	
Drawn By:		
Project Engineer:	СМЈ	
Approved By:	AAD	
Field Book:	360, 364	

**C1-02** 



### **EXISTING CONDITIONS NOTES:**

- - THE NSRS WERE NOT OBTAINED.

  - DATED 02/08/2022.

1. THE PURPOSE OF THE EXISTING CONDITIONS PLAN IS TO DEPICT READILY APPARENT PERTINENT EXISTING CONDITIONS AS OF FEBRUARY 2022. PLAN IS BASED ON FIELD OBSERVATIONS BY TRUDELL CONSULTING ENGINEERS AND INFORMATION PROVIDED ELECTRONICALLY BY PATHWAYS CONSULTING, LLC.

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Revi	sions
No.	Description

Date	By

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# Sunnymede Farms

Store 88 US 5 Hartland, Vermont

Sheet Title

# **Overall Existing Conditions Plan**

Date:	5/18/2022
Scale:	1''= 60'
Project Number:	21-358
Drawn By:	RMP
Project Engineer:	СМЈ
Approved By:	AAD
Field Book:	360, 364



		LEGEND	
	EXISTING	PROPOSED	REMOVED/ABANDONED
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GRAVEL DRIVE OR ROAD PAVED DRIVE OR ROAD WITH CURB			
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INDERDRAIN	UD		UD UD UD
OOF DRAIN	RD		RD RD RD
OOTING DRAIN	FD		FD FD FD
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LEGEND

#### **LEGEND NOTE:**

CALCULATED POINT

SOME INFORMATION MAY BE PROVIDED BY OTHERS AND COULD BE SHOWN WITH A DIFFERENT SYMBOL NOT SHOWN ON THIS LEGEND. HOWEVER, THEY ARE LABELED ON RESPECTIVE PLANS. IN SOME CASES A CHANGE IN SCALE OR PRINTER CAN ALTER INFORMATION TO NOT SHOW AN EXACT MATCH ON THIS LEGEND. IF ANY QUESTIONS EXIST CONTACT THE ENGINEER TO CLARIFY. ADDITIONAL LEGEND INFORMATION IS SUPPLIED SEPARATELY ON EROSION CONTROL PLANS AND SOME SURVEY PLATS.

Δ

### **CONSTRUCTION NOTES FOR CONTRACTOR & CLIENT/OWNER:**

CONTRACT DOCUMENTS COMMITTEE (EJCDC), LATEST EDITION. COPIES ARE AVAILABLE AT <u>WWW.NSPE.ORG/EJCDC</u>.

- 2. <u>UNDERGROUND IMPROVEMENTS:</u> THE LOCATION OF EXISTING UNDERGROUND UTILITIES AND IMPROVEMENTS SHOWN ARE ASSUMED BASED ON RESEARCH, UTILITY PLANS PROVIDED BY OTHERS, AND/OR SURFACE EVIDENCE AVAILABLE AND WERE OBTAINED IN A MANNER ISTENT WITH THE ORDINARY STANDARD OF PROFESSIONAL CARE AND HAVE NOT BEEN INDEPENDENTLY VERIFIED BY THE OWNER OR THE DESIGN ENGINEER.
- 3. DIFFERING SUBSURFACE OR PHYSICAL CONDITIONS: IF CONTRACTOR BELIEVES THAT ANY SUBSURFACE OR PHYSICAL CONDITION AT OR CONTIGUOUS TO THE SITE THAT IS UNCOVERED OR REVEALED EITHER: (1) IS OF SUCH A NATURE AS TO ESTABLISH THAT ANY "TECHNICAL DATA" AN UNUSUAL NATURE, AND DIFFERS MATERIALLY FROM CONDITIONS ORDINARILY ENCOUNTERED AND GENERALLY RECOGNIZED AS INHERENT IN WORK OF THE CHARACTER PROVIDED FOR IN THE PLANS/CONTRACT DOCUMENTS; THEN CONTRACTOR SHALL, PROMPTLY AFTER BECOMING AWARE THEREOF AND BEFORE FURTHER DISTURBING THE SUBSURFACE OR PHYSICAL CONDITIONS OR PERFORMING ANY WORK IN CONNECTION THEREWITH (EXCEPT IN AN EMERGENCY), NOTIFY OWNER AND ENGINEER ABOUT SUCH CONDITION. CONTRACTOR SHALL NOT FURTHER DISTURB SUCH CONDITION OR PERFORM ANY WORK IN CONNECTION THEREWITH (EXCEPT AS AFORESAID) UNTIL RECEIPT OF WRITTEN ORDER TO DO SO. ALL PARTIES INVOLVED (OWNER, ENGINEER, ARCHITECT AND MUNICIPALITY IF APPLICABLE) SHALL AGREE UPON HOW TO PROCEED AND ANY RELATED COST IMPLICATIONS.
- 4. UTILITIES: PRIVATE AND PUBLIC UTILITIES SUCH AS ELECTRIC, TELEPHONE, GAS, CABLE, FIBER OPTIC ETC, ARE THE RESPONSIBILITY OF THE RESPONSIBILITY COMPANY, ANY INFORMATION SHOWN BY TCE SHOULD BE CONSIDERED PRELIMINARY (USUALLY TO ASSIST WITH PERMITTING.)
- 5. DIGSAFE: IN ACCORDANCE WITH VERMONT STATE LAW (VSA TITLE 30 CHAPTER 86 AND PSB RULE 3,800) THE CONTACT DIGSAFE SYSTEMS, INC. "DIGSAFE." AT LEAST 48 HOURS, EXCLUDING SATURDAYS, AND LEGAL HOLIDAYS, UT NOT MORE THAN 30 DAYS BEFORE COMMENCING EXCAVATION ACTIVITIES, EXCEPT IN AN EMERGENCY. THE CONTRACTOR SHALL BE RESPONSIBLE FOR PRE-MARKING THE SITE AND MAINTAINING DESIGNATED MARKINGS. FOR MORE INFORMATION ON DIGSAFE REQUIREMENTS SEE <u>WWW.DIGSAFE.COM</u> OR (CALL 811).
- 6. JOBSITE SAFETY: NEITHER THE PROFESSIONAL ACTIVITIES OF TRUDELL CONSULTING ENGINEERS (TCE), NOR THE PRESENCE OF TCE OR ITS EMPLOYEES AND SUB CONSULTANTS AT A CONSTRUCTION SITE, SHALL RELIEVE THE GENERAL CONTRACTOR AND ANY OTHER ENTITY OF THEIR IN ACCORDANCE WITH THE CONTRACT DOCUMENTS AND ANY HEALTH OR SAFETY PRECAUTIONS REQUIRED BY ANY REGULATORY AGENCIES. TCE AND ITS PERSONNEL HAVE NO AUTHORITY TO EXERCISE ANY CONTROL OVER ANY CONTRACTION CONTRACTOR OR OTHER ENTITY OR THEIR EMPLOYEES IN CONNECTION WITH THEIR WORK OR ANY HEALTH OR SAFETY PRECAUTIONS. THE CLIENT AGREES THAT THE GENERAL CONTRACTOR IS SOLELY RESPONSIBLE FOR JOBSITE SAFETY, AND WARRANTS THAT THIS INTENT SHALL BE MADE EVIDENT IN THE CLIENT'S AGREEMENT WITH THE GENERAL CONTRACTOR. THE CLIENT ALSO AGREES THAT THE CLIENT, TCE AND TCE'S CONSULTANTS SHALL BE INDEMNIFIED AND SHALL BE MADE ADDITIONALLY INSURED UNDER THE GENERAL CONTRACTOR'S GENERAL LIABILITY INSURANCE POLICY.
- 7. CODES AND STANDARDS COMPLIANCE: TCE SHALL EXERCISE USUAL AND CUSTOMARY PROFESSIONAL CARE IN ITS EFFORTS TO COMPLY WITH CODES, STANDARDS, REGULATIONS AND ORDINANCES IN EFFECT. THE OWNER ACKNOWLEDGES THAT SUCH REQUIREMENTS MAY BE OR GUARANTEE THAT THE PROJECT WILL COMPLY WITH ALL INTERPRETATIONS OF SUCH REQUIREMENTS.
- 8. CONSTRUCTION OBSERVATION: TCE MAY VISIT THE PROJECT AT APPROPRIATE INTERVALS DURING CONSTRUCTION TO BECOME GENERALLY FAMILIAR WITH THE PROGRESS AND QUALITY OF THE CONTRACTOR'S WORK AND TO DETERMINE IF THE WORK IS PROCEEDING IN GENERAL SHALL NOT HAVE RESPONSIBILITY FOR, THE ACTS OR OMISSIONS OF ANY CONTRACTOR, SUPPLIER OR ANY OTHER ENTITY FURNISHING MATERIALS OR PERFORMING ANY WORK ON THE PROJECT. TCE SHALL NOT SUPERVISE, DIRECT OR HAVE CONTROL OVER THE CONTRACTOR'S WORK NOR HAVE ANY RESPONSIBILITY FOR THE CONSTRUCTION MEANS, METHODS, TECHNIQUES, SEQUENCES OR PROCEDURES OF THE CONTRACTOR. IF THE OWNER DESIRES MORE EXTENSIVE PROJECT OBSERVATION OR FULL-TIME PROJECT REPRESENTATION, THE OWNER SHALL REQUEST SUCH SERVICES BE PROVIDED BY TCE AS ADDITIONAL SERVICES.
- 9. THE CONTRACTOR SHALL REPAIR/RESTORE ALL DISTURBED AREAS (ON OR OFF THE SITE) AS A DIRECT OR INDIRECT RESULT OF THE CONSTRUCTION. ALL GRASSED AREAS SHALL BE MAINTAINED UNTIL FULL VEGETATION IS ESTABLISHED. MAINTAIN ALL TREES OUTSIDE OF CONSTRUCTION LIMITS.
- 10. IN ADDITION TO THE REQUIREMENTS SET IN THESE PLANS AND SPECIFICATIONS, THE CONTRACTOR SHALL COMPLETE THE WORK IN ACCORDANCE WITH ALL PERMIT CONDITIONS, LOCAL PUBLIC WORKS STANDARDS AND ALL CONSTRUCTION SAFETY REGULATIONS.
- 11. ANY DEWATERING NECESSARY FOR THE COMPLETION OF THE SITEWORK SHALL BE CONSIDERED AS PART OF THE CONTRACT AND SHALL BE THE CONTRACTOR'S RESPONSIBILITY.
- 12. IF THERE ARE ANY CONFLICTS OR INCONSISTENCIES WITH THE PLANS OR SPECIFICATIONS, THE CONTRACTOR SHALL CONTACT THE ENGINEER FOR VERIFICATION BEFORE WORK CONTINUES ON THE ITEM(S) IN QUESTION.
- 14. CONTRACTOR IS RESPONSIBLE FOR COORDINATION WITH ALL RELEVANT PARTIES (INCLUDING, BUT NOT LIMITED TO OWNER, ARCHITECT AND UTILITY COMPANIES) TO DETERMINE FINAL LAYOUT AND DESIGN.
- 15. DESIGN AND CONSTRUCTION OF PEDESTRIAN WALKS, RAMPS AND DECKS BETWEEN BUILDINGS AND PARKING LOTS IS PROVIDED BY THE ARCHITECT AND INCORPORATED INTO THE BUILDING DESIGN, UNLESS INDICATED OTHERWISE.
- 16. ALL WATER LINE TAPS SHALL BE LIVE TAPS; EXISTING WATER LINE MUST REMAIN IN SERVICE DURING CONNECTION, UNLESS INDICATED OTHERWISE.
- 17. ROOF DOWNSPOUT CAN CONNECT TO ROOF DRAIN MANIFOLD (RD) AS DETERMINED BY ARCHITECT AND OWNER. THIS CONNECTION PIPE IS INCLUDED AS PART OF THE DESIGN PLAN BUT NOT SHOWN TO ALLOW FLEXIBILITY IN LOCATION AS NEEDED.
- 18. THRUST BLOCKS FOR PRESSURE LINES ARE NOT SHOWN FOR CLARITY PURPOSES. PROVIDE THRUST BLOCKS AT ALL BENDS, TEE AND REDUCES. PROJECT ENGINEER TO OBSERVE ALL THRUST BLOCKS PRIOR TO BACKFILL.
- 19. WATER MAIN OPERATED AT HIGH PRESSURE. ALL BUILDINGS SHALL CONFIRM STATIC INTAKE PRESSURE AND PROVIDE PRESSURE-REDUCING VALVES AS DEEMED APPROPRIATE BY THE MECHANICAL ENGINEER (OR ARCHITECT.) 20. CONTRACTOR TO SUPPLY DAYLIGHT PIPING FOR FOOTING DRAINS WITHIN CONSTRUCTION LIMITS. THE EXACT LOCATION MAY NOT BE CRITICAL. COORDINATE WITH OWNER AND PROJECT ENGINEER.
- 21. FOOTING DRAINS AROUND BUILDING MAY BE SHOWN BY OTHERS (BECAUSE IT IS WITHIN THE 5' ZONE AROUND BUILDING). FOOTING DRAINS AND PIPE TO DAYLIGHT SHALL BE INCLUDED EVEN IF NOT SHOWN. DAYLIGHT PIPE LOCATION TO SWALE MAY NOT BE CRITICAL SO LONG AS IT DOES NOT CREATE ANY CONFLICT WITH OTHER UTILITIES, OR IMPACT ENVIRONMENTALLY SENSITIVE AREAS SUCH AS WETLANDS.
- 22. SEWER CONNECTIONS TO EXISTING MANHOLES SHALL INCLUDE WATERTIGHT CONNECTIONS, REFORMING INVERT TO PROVIDE SMOOTH FLOW STREAM AND TESTING TO ENSURE STRUCTURE IS WATERTIGHT. IF AN EXISTING MANHOLE IS FOUND NOT TO BE WATERTIGHT IT SHALL BE EXPOSED AND REPAIRED ON THE OUTSIDE. PRIOR TO CONNECTING TO EXISTING MANHOLES, SUBMIT SHOP DRAWINGS ON CORE LOCATION, ANY REQUIRED PIPING (FOR DROP MANHOLES) AND CHANGES TO INVERT FORM. 23. FINAL RIMS OF SEWER MANHOLES AND WATER VALVES SHALL BE CONFIRMED AND COORDINATED WITH FINAL SITE GRADING. MINOR ADJUSTMENTS FROM DESIGN GRADES MAY BE REQUIRED BY OWNER OR ENGINEER AND SHALL BE INCLUDED.
- 24. ROCK REMOVAL WORK FOR BOULDERS UNDER 2.5 CUBIC YARDS IS INCLUDED AS PART OF EXCAVATION. ANY ROCK REMOVAL FOR 2.5 CUBIC YARDS OR GREATER SHALL BE TREATED AS LEDGE REMOVAL. THIS SHOULD BE REVIEWED AND AGREED UPON BY OWNER PRIOR TO CONDUCTING ROCK REMOVAL.
- 25. THE <u>GENERAL CONTRACTOR IS REQUIRED TO CONFORM TO THE STRICTEST INTERPRETATION OF THE CONTRACT DRAWING, SPECIFICATION, PERMITS AND CONSTRUCTION CONTRACT.</u> ALL EARTH MATERIAL RECEIVED OR DISPOSED FROM OUTSIDE SOURCES SHALL COMPLY WITH APPLICABLE PERMITS AND REGULATIONS. SHOP DRAWING SUBMITTALS SHALL INCLUDE CONTRACTOR'S CERTIFICATION STATEMENT OF COMPLIANCE AND COPIES OF RELEVANT PERMITS FOR OUTSIDE SOURCES.
- 26. CONTRACTOR SHALL PAY FOR ALL REQUIRED TESTING. THIS SHALL INCLUDE BUT IS NOT LIMITED TO: SOIL TESTING, COMPACTION TESTING, SIEVE ANALYSIS, CONCRETE TESTING, ASPHALT PENETRATION TESTING, BACTERIOLOGICAL TESTING FOR WATER AND OTHER TESTING AS PART OF STANDARD PRACTICE FOR A CONSTRUCTION PROJECT OF THIS NATURE, UNLESS INDICATED OTHERWISE AND APPROVED BY THE OWNER.
- 27. ALL ADA ACCESSIBLE WALKWAYS CANNOT EXCEED 5% RUNNING SLOPE AND 2% CROSS SLOPE, RAMPS CANNOT EXCEED 8.33% RUNNING SLOPE AND 2% CROSS SLOPE, AND HANDICAP PARKING STALLS AND ACCESS AISLES CANNOT EXCEED 2% SLOPE IN ANY DIRECTION. PRIOR TO CONSTRUCTION, CONTRACTOR SHALL NOTIFY ENGINEER OF ANY DISCREPANCIES.

### **SPECIAL NOTE:** FOR CLARITY, ALL ORIGINAL COLOR SHEETS MUST BE REPRODUCED IN COLOR

CONTRACT DOCUMENTS: THESE PLANS WERE PREPARED BY TRUDELL CONSULTING ENGINEERS (TCE) AND ARE INTENDED TO BE USED IN CONJUNCTION WITH THE STANDARD GENERAL CONDITIONS OF THE CONSTRUCTION CONTRACT, #C-700 PREPARED BY THE ENGINEERS JOINT

13. SEWER LATERAL CONNECTIONS ARE SOMETIMES NOT SHOWN FOR CLARITY. CONTRACTOR TO CONSULT WITH ENGINEER AND SUPPLY BENDS, CLEANOUTS, ETC. AS NECESSARY TO FACILITATE PROPER CONNECTION BETWEEN FOUNDATION WALL AND SEWER MAIN LINE.



## **ENGINEERING**•SURVEY

**PLANNING • ENVIRONMENTAL** 478 BLAIR PARK ROAD | WILLISTON, VERMONT 05495 802 879 6331 | WWW.TCEVT.COM

Revisions No. Description

Date

#### PARCEL ID: 004-047

Use of These Drawings 1. Unless otherwise noted, these Drawings are intended for preliminary planning, coordination with other disciplines or utilities, and/or approval from the regulatory authorities. They are not intended as construction drawings unless noted as such or marked approved by a regulatory authority.


2. By use of these drawings for construction of the Project, the Owner represents that they have reviewed, approved, and accepted the drawings, obtained all necessary permits, and have met with all applicable parties/disciplines, including but not limited to, the Engineer and the Architect, to insure these plans are properly coordinated including, but not limited to, contract documents, specifications, owner/contractor agreements, building and mechanical plans, private and public utilities, and other pertinent permits for construction.

3. Owner and Architect, are responsible for final design and location of buildings shown, including an area measured a minimum five (5) feet around any building and coordinating final utility connections shown on these plans.

4. Prior to using these plans for construction layout, the user shall contact TCE to ensure the plan contains the most current revisions.

5. These Drawings are specific to the Project and are not transferable. As instruments of service, these drawings, and copies thereof, furnished by TCE are its exclusive property. Changes to the drawings may only be made by TCE. If errors or omissions are discovered, they shall be brought to the attention of TCE immediately.

6. It is the User's responsibility to ensure this copy contains the most current revisions.

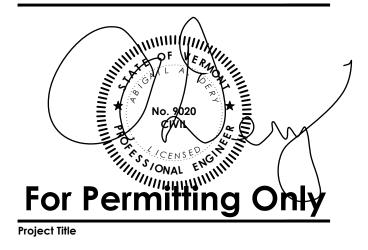

### Sunnymede Farms

Store 88 US 5 Hartland, Vermont

Sheet Title

## Legend & Notes

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